### DETAILED DEVELOPMENT PLAN STAFF REPORT



**Docket Number:** 2018-04-DP

Public Hearing Date: March 15, 2018

**Pre-Application Conference:** February 20, 2018

<u>Description of Request</u>: The applicant has applied for approval of a Detailed Development Plan on a tract of land totaling 32.64 acres located at 106 Cosma Drive. The plan proposes the construction of a mill shop, truss facility and storage buildings totaling 152,770 square feet with plans to construct two additional buildings for a future expansion of another 81,500 square feet for a total development of 234,270,579 square feet. This property is zoned **HI** (Heavy Industrial) with a general development plan.

### **Applicant/ Property Owner:**

Carter Lumber Company Charles Price 601 Tallmadge Road Kent, OH 44240

**Location of Property:** 106 Cosma Drive

<u>PVA Parcel Numbers</u>: 062A-60-15B <u>Current Zoning</u>: HI (Heavy Industrial)

**Property Size:** 32.64 acres **Existing Land Use:** Agricultural

### **Existing Land Use of the Surrounding Area:**

The surrounding area is predominantly comprised of industrial and agricultural land uses. There are single-family residential, multi-family residential, commercial, public and public-institutional uses in the area as well. There are also some vacant tracts in the general vicinity.

### **Zoning History:**

**AG** (Agriculture) was the original zoning for the property. The property was rezoned from **AG** (Agriculture) to **HI** (Heavy Industrial) in August, 2003.

### DETAILED DEVELOPMENT PLAN REVIEW

Sec **3.11.5** of the Zoning Ordinance states the following:

<u>Detailed Development Plan Required</u>: Prior to the issuance of building permits, a detailed development plan shall be approved by the Planning Commission for the following:

• All industrial developments or uses containing over 75,000 sq. ft. in total building area.

The Applicant has submitted a **Detailed Development Plan t** (see attached) to be reviewed for compliance with the following **Binding Elements** recorded in Deed Book 870 Page 668:

- 1. The Affected Property shall be developed and maintained in accordance with all applicable laws pertaining to landscaping and buffering, including the Zoning Ordinance Sections 4.7.3.D and 4.6.8.D. In addition thereto, the development shall include all the earthen berms, vegetation barriers, screens and open spaces set out on the Property Owner's "Conceptual Site Layout Plan" and "Typical Berm Cross Section" filed herewith as Exhibit "1" and Exhibit "2" to these Binding Elements; provided however, the Conceptual Site Layout Plan is otherwise subject to final engineering and the Property Owner is not otherwise bound by the details thereof. A berm, screening or buffer area may be deleted or reduced at any location on the Conceptual Site Layout Plan if all landowners adjoining that location agree and the above landscaping and buffering provisions with the Zoning Ordinance are complied with.
- 2. The Affected Property shall be developed with public sanitary sewers, curbs, gutters, bike trails and walking trails as illustrated on the Property Owner's "Typical Main Boulevard Cross Section" filed herewith as Exhibit "3". All new utility lines shall be underground (as permitted by utility company). All application provisions of the ordinances and other laws pertaining to public water and sewer standards and fire control shall be complied with.
- 3. The development and use on the Affected Property shall be in compliance with all applicable provisions of any law or ordinance regarding noise control (see Bowling Green Ordinance Section 9-3).
- 4. No use of the Affected Property may have or make products which could be hazardous to human life and property until provisions for the proper control thereof have been made in accordance with all applicable federal, state and local regulations.
- 5. Loading docks, vehicle use areas, public use areas and outside storage areas shall be screened from adjacent residential developments or from all public streets or in compliance with any presently adopted landscaping ordinance.
- 6. Only one freestanding sign, excluding directional signs, shall be placed on each developed site. All freestanding signs shall be monument signs no more than 7 feet high with no face more than 100 sq. ft. and shall be landscaped. However, one entrance sign shall be allowed at the entrances off US 68/KY 80 provided that it is a monument style sign no more than 7 feet high.

## **DETAILED DEVELOPMENT PLAN REVIEW (Continued)**

- 7. When located adjacent to a residential area, site lighting shall be directed downward and away from adjacent residential uses and shall be shielded to prevent light trespass or reflection onto adjoining properties. This lighting may be shoebox style or any other style that is architecturally pleasing and minimizes glare and direct light on adjoining property.
- 8. All sources of malodorous emissions, regardless of how benign, shall be abated as determined and required under all applicable federal, state and local regulations. New sources of malodorous emissions must not be located where they would be inconsistent with applicable federal, state and local regulations.
- 9. All future lots within this property shall contain at least twenty percent (20%) green space. All parking areas within the tract shall be landscaped and contain at least twenty percent (20%) green space for parking aisles and islands. Paved parking areas shall be set back at least 25 feet from any property line.
- 10. All public streets and access roads shall be landscaped with trees, shrubs and vegetative ground cover.
- 11. The Property Owner shall have the responsibility of providing for the installation of all roadway and intersection improvements (as specified in the Traffic Impact Study prepared by Qk4 in July 2003 as pertaining to Phase 2 Development, including traffic lights as illustrated on attached Exhibit 6 entitled "US Highway 68-80 Intersection") as are determined to be needed by the Kentucky Transportation Cabinet ("KTC"); City-County Planning Commission and City of Bowling Green. In addition, these improvements shall include a second westbound right turn lane at US 31 W / McGinnis Quarry Road intersection and a second northbound left turn lane at proposed entrance to the tract onto US 68/KY 80 and any improvements to Hays-Martin Road.
- 12. Special storm water drainage techniques shall be provided on each lot throughout the Affected Property as illustrated on the Property Owner's "Conceptual Storm Water Management System" filed herewith as "Exhibit 4" as defined in the "Site Evaluation and Design Assistance for the proposed Kentucky Tri-Modal Transpark Final Report" dated February 28, 2003 prepared by WKU Center for Cave and Karst Studies, or by such superior methods as may be identified through the use of best practices and reviewed by the Executive Director of the City-County Planning Commission.
- 13. The following uses shall not be permitted and are prohibited on the Affected Property even though they may otherwise be permitted uses under the Zoning Ordinance: mining; quarrying; sanitary landfill; construction and demolition debris landfill; waste composting energy recovery plant; hazardous waste collection site; solid waste transfer station; sewage treatment plant; slaughter house; concrete batching and asphalt mixing; tannery; live animal or poultry sales; adult entertainment; confined poultry or animal feeding operation; or land farming.
- 14. No principal building shall be located within 150 feet of a residential use and no accessory building shall be located within 100 feet of a residential use.
- 15. Before any development on the Affected Property occurs, all materials and debris identified in the Environmental Assessments dated July 24, 2003 performed by EnSafe must be mitigated and disposed of properly in an approved landfill according to applicable laws.

## **DETAILED DEVELOPMENT PLAN REVIEW (Continued)**

- 16. Microgravity analysis, electric resistivity, high impact compaction, subterranean boring or other methods as defined in the "Site Evaluation and Design Assistance for the proposed Kentucky Tri-Modal Transpark Final Report" dated February 28, 2003 prepared by the WKU Center for Cave and Karst Studies, shall be used with the development of roads, improved drainage basins and buildings within the Affected Property.
- 17. The existing cemetery located on the property shall be either properly screened and maintained by the owner or properly relocated as required by the State of Kentucky.
  - 18. Binding Elements 4 and 8 shall become plat restrictions upon the recording of any plat.

### STAFF REVIEW

This plan was reviewed based on the **HI** (Heavy Industrial) zone and Binding Elements as follows:

	Allowed / Required	<u>Provided</u>				
Lot Coverage:	80 % (Binding Elements)	71.08 %				
Setbacks:	Front: 50' (plat) – Cosma Drive	81'				
	Side: 0' (North)	10'				
	Side: 0' (Southwest)	184.1'				
	Rear: 0' (South)	25'				
Parking:	80 spaces (1 space/employee max. shift)	87 spaces				
Building Height:	100'	25'				
Landscaping:	The landscaping plan submitted meets the requirements of the Zoning Ordinance and the Binding Elements and is approved.					
Signage:	Only one freestanding sign, excluding directional signs, shall be placed on each developed site. All freestanding signs shall be monument signs no more than seven (7) feet high with no face with more than 100 sq. ft. and shall be landscaped. (Binding Element number 6)					
<u>Drainage:</u>	The drainage plan will be reviewed by the City of Bowling Green Public Works Department and final approval will be required, prior to the issuance of a building permit.					
<u>Traffic:</u>	A Traffic Impact Study (TIS) was not requ Development Plan application.	ired to be submitted with this Detailed				
Access:	The development has one (1) proposed access point onto Cosma Drive. The proposed access point has been reviewed and approved by the City of Bowling Green Public Works Department.					

### **STAFF REVIEW**

The applicant has submitted a Detailed Development Plan to construct a mill shop, truss facility and storage buildings totaling 152,770 square feet with plans to construct two additional buildings for a future expansion of another 81,500 square feet for a total development of 234,270 square feet. The proposed development plan meets the requirements of the Zoning Ordinance and the Binding Elements, except for the suggested conditions of approval listed below.

### SUGGESTED CONDITIONS OF APPROVAL

- 1) The drainage plan will be reviewed by the City of Bowling Green Public Works Department and final approval will be required, prior to the issuance of a building permit;
- 2) Plat must be recorded revising the existing utility and drainage easements and removing the existing platted building setback, prior to the issuance of a building permit.

### **MOTIONS**

### MOTION TO APPROVE:

I make the motion to **approve** the Detailed Development Plan, Docket number **2018-04-DP** subject to the following conditions:

- 1) The drainage plan will be reviewed by the City of Bowling Green Public Works Department and final approval will be required, prior to the issuance of a building permit;
- 2) Plat must be recorded revising the existing utility and drainage easements and removing the existing platted building setback, prior to the issuance of a building permit.

My motion is based upon the Detailed Development Plan's compliance with Section 3.11.6 of the Warren County Zoning Ordinance.

OR

### MOTION TO DENY:

I make the motion to **deny** the Detailed Development Plan, Docket number **2018-04-DP**. My motion is based upon the Detailed Development Plan's failure to meet the requirements of Section 3.11.6 of the Warren County Zoning Ordinance as follows:

I further request that the staff transmit a written notice to the applicant within 10 days of this action detailing the reasons for denial.

# DETAILED DEVELOPMENT PLAN FOR

# CARTER LUMBER COMPANY KENTUCKY TRANSPARK, LOT 15-2 106 Cosma Drive

BOWLING GREEN, KY 42101 FEBRUARY 15, 2018 REVISED MARCH 6, 2018



### DRAWING INDEX

CIVIL

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C2.2	SITE LAYOUT ENLARGED
C3.1	SITE GRADING AND DRAINAGE ENLARGED
C3.2	SITE GRADING AND DRAINAGE ENLARGED
C4.1	PRE - EROSION & SEDIMENT CONTROL ENLARGED
C4.2	PRE - EROSION & SEDIMENT CONTROL ENLARGED
C4.3	POST DEVELOPMENT EROSION CONTROL ENLARGE
C4.4	POST DEVELOPMENT EROSION CONTROL ENLARGE
C5	WATER & SEWER PLAN
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L1.3	LANDSCAPE PLAN ENLARGEMENT
SL1	SITE LIGHTING PLAN
A3.0	TRUSS BUILDING ELEVATIONS
A3.1	MILL FABRICATION BUILDING ELEVATIONS


DEVELOPER:

CARTER LUMBER 601 TALLMADGE ROAD KENT, OHIO 44240 CONTACT: CHARLES PRICE TELEPHONE: 330-221-6249 PARCEL OWNER:

CARTER LUMBER COMPANY 601 TALLMADGE ROAD KENT, OHIO 44240 CONTACT: CHARLES PRICE TELEPHONE: 330-673-6100 (EXT. 270) CIVIL ENGINEER/ SURVEYOR/LANDSCAPE ARCHITECT:

ARNOLD CONSULTING ENGINEERING SERVICES, INC. PO BOX 1338 BOWLING GREEN, KY 42101 CONTACT: AARON ARNOLD TELEPHONE: 270-780-9445 ARCHITECT:

SEWELL & SEWELL ARCHITECTS 996 WILIKINSON TRACE, SUITE B4 BOWLING GREEN, KY 42103 CONTACT: NICK SEWELL TELEPHONE: 270-904-3388

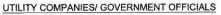

PLANNING COMMISSION: CITY-COUNTY PLANNING COMMISSION 1141 STATE STREET BOWLING GREEN, KY 42101 CONTACT: MR. STEVE MCWHORTER TELEPHONE: (270)842-1953

BUILDING INSPECTIONS: CITY OF BOWLING GREEN BUILDING & INSPECTION DIVISION 707 E. MAIN AVE. BOWLING GREEN, KY 42101 CONTACT: JEREMY SEGUR TEI EPHONE: (270) 332-3615 WATER & SEWER: WARREN COUNTY WATER DISTRICT 523 US-31W BYPASS BOWLING GREEN, KY 42101 CONTACT: TIM MINNICKS TELEPHONE: (270) 842-0052

CITY ENGINEER: BOWLING GREEN CITY PUBLIC WORKS 1011 COLLEGE STREET BOWLING GREEN, KY 42101 CONTACT: MELISSA CANSLER, P.E. TELEPHONE: (270)393-3657 ELECTRICITY: WARREN RECC 951 FAIRWIEW AVENUE BOWLING GREEN, KY 42101 CONTACT: JONATHAN LINDSEY TELEPHONE: (270) 842-5214


GAS: ATMOS ENERGY 2850 RUSSELLVILLE ROAD BOWLING GREEN, KY 42101 CONTACT: BYRON OOST TELEPHONE: (270)901-1710 TELEPHONE: AT&T 1061 LOVERS LANE BOWLING GREEN, KY 42103 CONTACT: BUZZ COLBURN TELEPHONE: (270)782-4811

CABLE: SPECTRUM COMMUNICATIONS 515 DOUBLE SPRINGS RD. BOWLING GREEN, KY 42103 CONTACT: AMY WILLIAMS TELEPHONE: (520) 357-4710







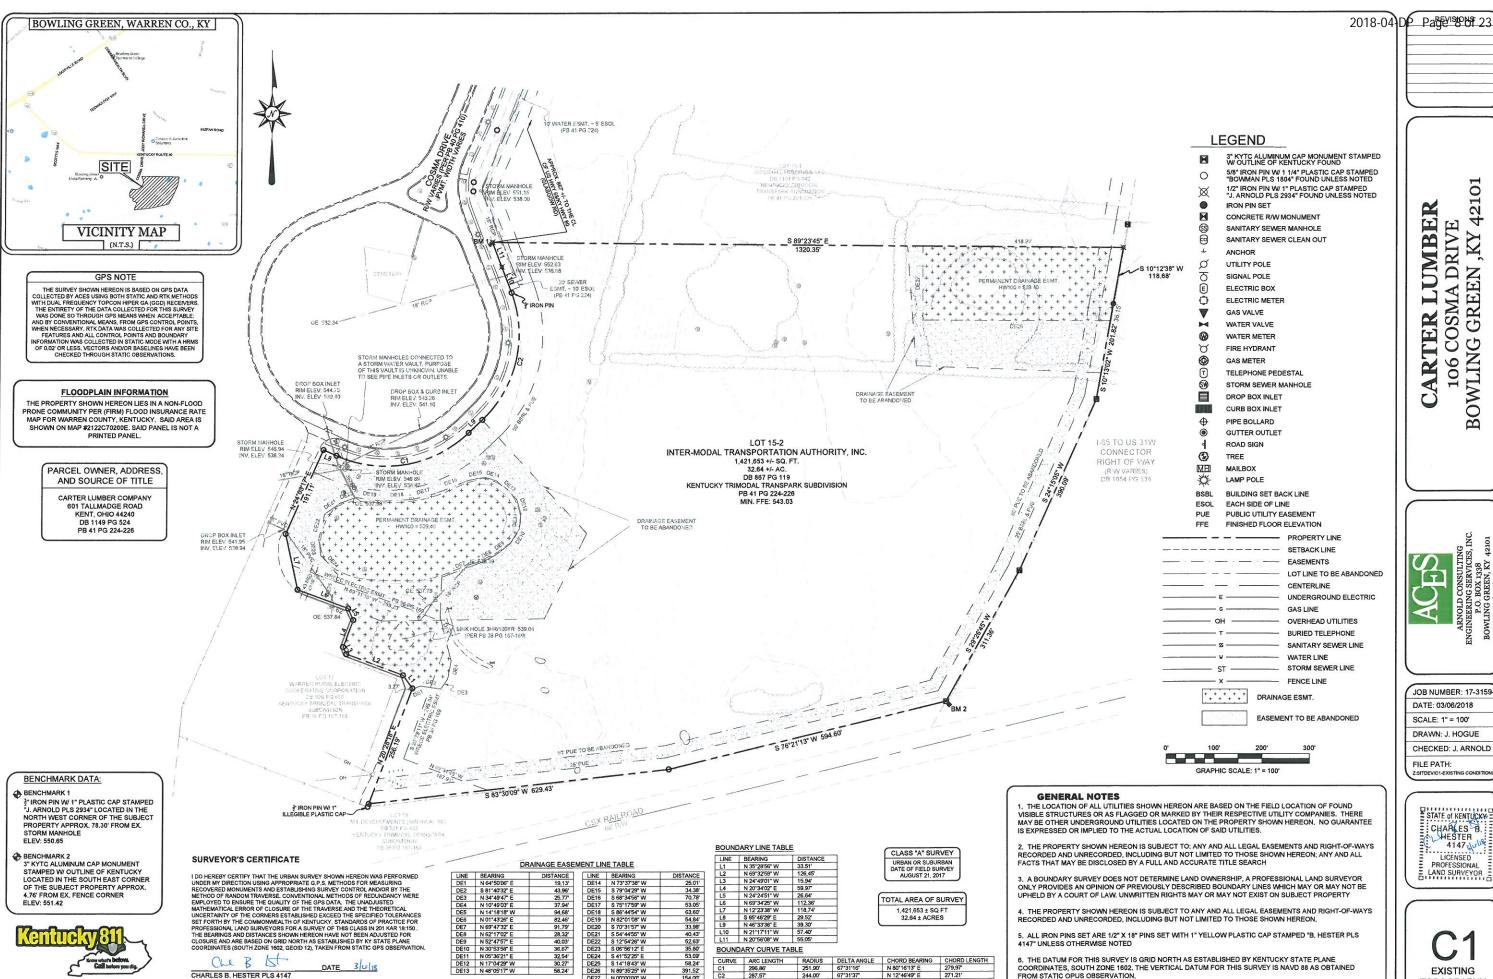

L11 N 20"56"08" W BOUNDARY CURVE TABLE

 CURVE
 ARC LENGTH
 RADIUS
 DELTA ANGLE
 CHORD BEARING
 CHORD LENGTH

 C1
 296,86°
 251.90°
 67°31'16°
 N 80°16'13° E
 279.97°

Che B 5t

CHARLES B. HESTER PLS 4147

DATE 3/4/18

42101

LUMBER

CARTER

DRIVE

COSMA DE

106 CC BOWLING

JOB NUMBER: 17-3159-1 DATE: 03/06/2018

SCALE: 1" = 100' DRAWN: J. HOGUE

CHECKED: J. ARNOLD FILE PATH:

> STATE OF KENTUCKY CHARLES B. 4147 2/0/18 LICENSED PROFESSIONAL LAND SURVEYOR

**EXISTING TOPOGRAPHY** 

6. THE DATUM FOR THIS SURVEY IS GRID NORTH AS ESTABLISHED BY KENTUCKY STATE PLANE COORDINATES, SOUTH ZONE 1602, THE VERTICAL DATUM FOR THIS SURVEY IS NAVD 88 AS OBTAINED

FROM STATIC OPUS OBSERVATION.

CARTER LUMBER 106 COSMA DRIVE BOWLING GREEN ,KY 42101

ARNOLD CONSULTING
ENGINEERING SERVICES, INC.
P.O. BOX 1338
BOWLING GREEN, KY 42101

JOB NUMBER: 17-3159-L DATE: 03/06/2018 SCALE: 1" = 100'


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CHECKED: A. ARNOLD


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C2.0

OVERALL SITE
LAYOUT



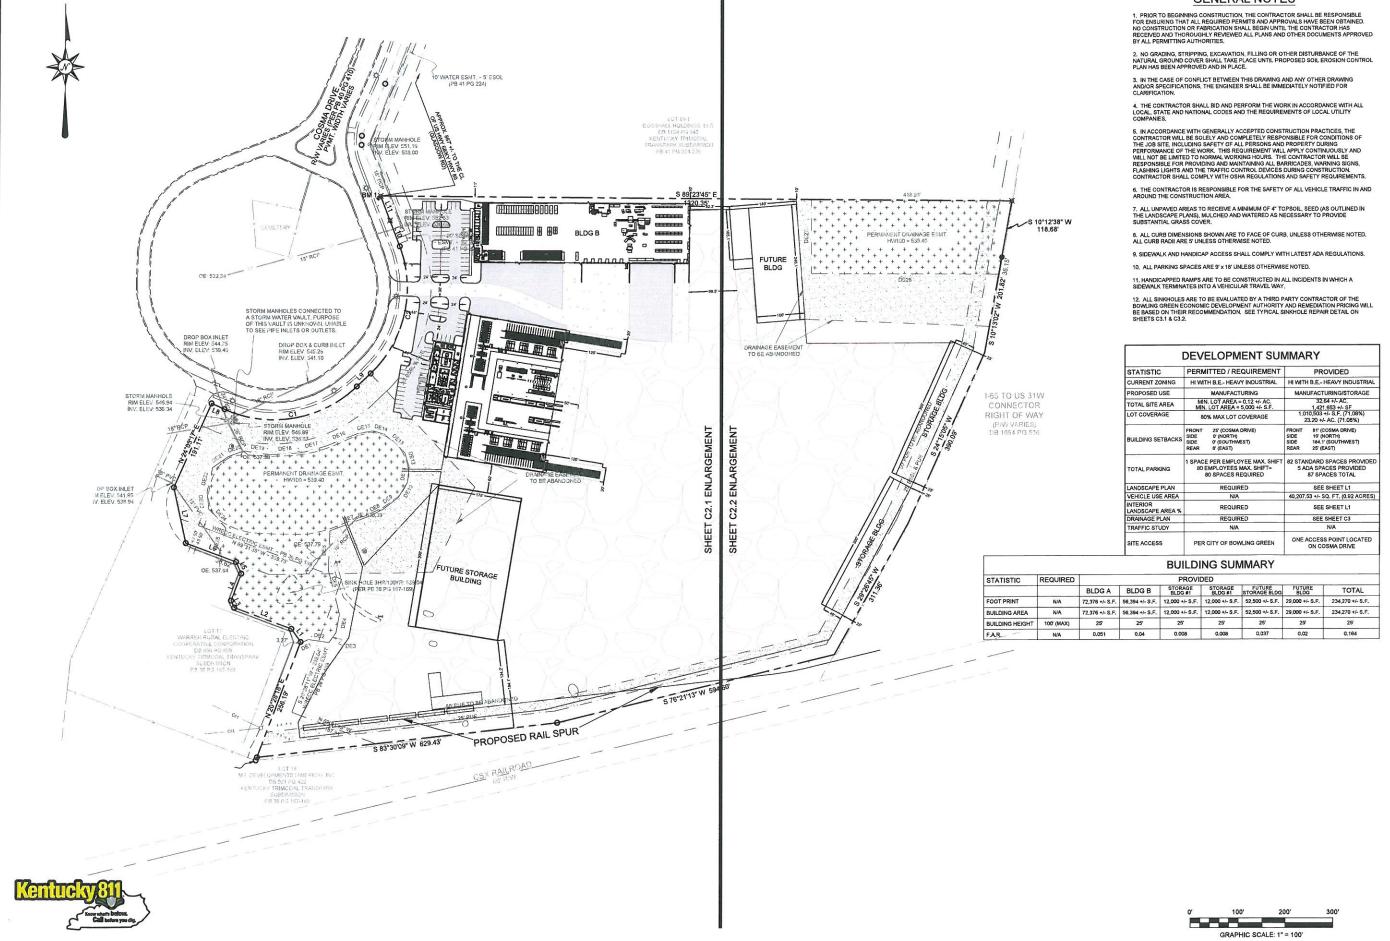

2101 CARTER LUMBER 5 COSMA DRIVE NG GREEN ,KY 42 BOWLING 106

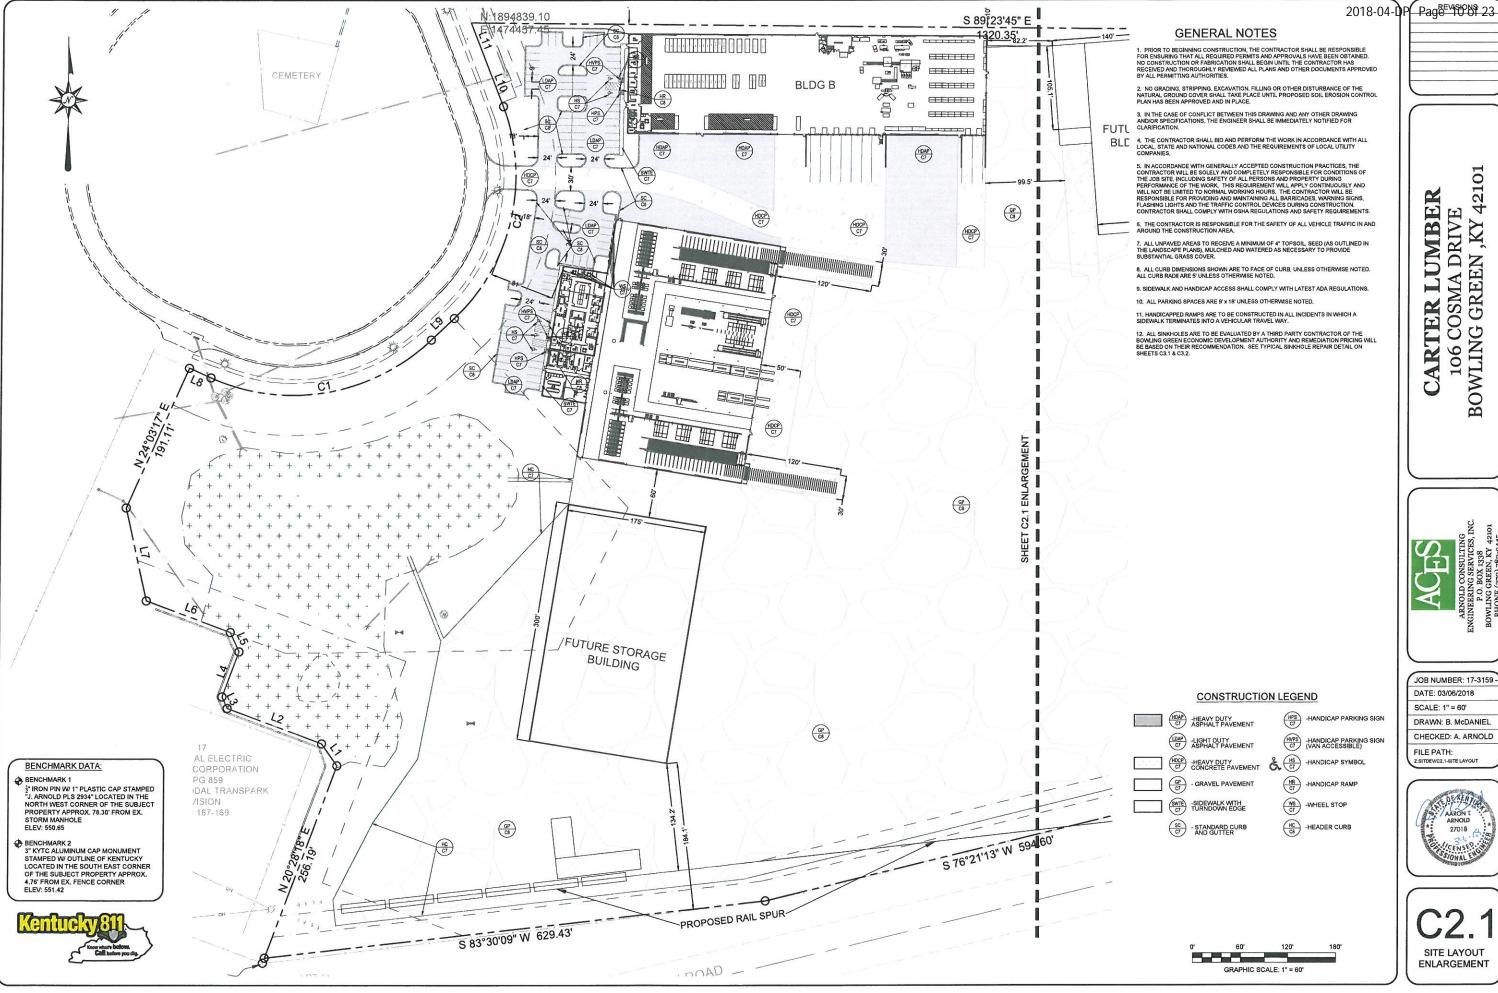JOB NUMBER: 17-3159 -DATE: 03/06/2018

CHECKED: A. ARNOLD

SCALE: 1" = 60" DRAWN: B. McDANIEL

FILE PATH:



SITE LAYOUT **ENLARGEMENT** 

- 1. PRIOR TO BEGINNING CONSTRUCTION, THE CONTRACTOR SHALL BE RESPONSIBLE FOR ENSURING THAT ALL REQUIRED PERMITS AND APPROVALS HAVE BEEN OBTAINED. NO CONSTRUCTION OF A FABRICATION SHALL BEGIN LINTLE HE CONTRACTOR HAS RECEIVED AND THOROUGHLY REVIEWED ALL PLANS AND OTHER DOCUMENTS APPROVED BY ALL PERMITTING AUTHORITIES.
- 2. NO GRADING, STRIPPING, EXCAVATION, FILLING OR OTHER DISTURBANCE OF THE NATURAL GROUND COVER SHALL TAKE PLACE UNTIL PROPOSED SOIL EROSION CONTROL PLAN HAS BEEN APPROVED AND IN PLACE.
- 3. IN THE CASE OF CONFLICT BETWEEN THIS DRAWING AND ANY OTHER DRAWING AND/OR SPECIFICATIONS, THE ENGINEER SHALL BE IMMEDIATELY NOTIFIED FOR CLARIFICATION.
- 4. THE CONTRACTOR SHALL BID AND PERFORM THE WORK IN ACCORDANCE WITH ALL LOCAL, STATE AND NATIONAL CODES AND THE REQUIREMENTS OF LOCAL UTILITY COMPANIES.
- 5. IN ACCORDANCE WITH GENERALLY ACCEPTED CONSTRUCTION PRACTICES, THE CONTRACTOR WILL BE SOLELY AND COMPLETELY RESPONSIBLE FOR CONDITIONS OF THE JOB SITE, INCLUDING SAFETY OF ALL PERSONS AND PROPERTY DUINING PERFORMANCE OF THE WORK. THIS REQUIREMENT WILL APPLY CONTINUOUSLY AND WILL NOT BE LIMITED TO NORMAL WORKING HOURS. THE CONTRACTOR WILL BE RESPONSIBLE FOR PROVIDING AND MAINTAINING ALL BARRICADES, WARNING SIGNS, FLASHING LIGHTS AND THE TRAFFIC CONTROL DEWCES DURING CONSTRUCTION, CONTRACTOR SHALL COMPLY WITH OSHA REGULATIONS AND SAFETY REQUIREMENTS.
- 6. THE CONTRACTOR IS RESPONSIBLE FOR THE SAFETY OF ALL VEHICLE TRAFFIC IN AND AROUND THE CONSTRUCTION AREA.
- 7. ALL UNPAVED AREAS TO RECEIVE A MINIMUM OF 4° TOPSOIL, SEED (AS OUTLINED IN THE LANDSCAPE FLANS), MULCHED AND WATERED AS NECESSARY TO PROVIDE SUBSTANTIAL GRASS COVER.
- 8. ALL CURB DIMENSIONS SHOWN ARE TO FACE OF CURB, UNLESS OTHERWISE NOTED. ALL CURB RADII ARE 5 UNLESS OTHERWISE NOTED.
- 9. SIDEWALK AND HANDICAP ACCESS SHALL COMPLY WITH LATEST ADA REGULATIONS
- 10. ALL PARKING SPACES ARE 9' x 18' UNLESS OTHERWISE NOTED.
- 11. HANDICAPPED RAMPS ARE TO BE CONSTRUCTED IN ALL INCIDENTS IN WHICH A SIDEWALK TERMINATES INTO A VEHICULAR TRAVEL WAY.
- 12. ALL SINKHOLES ARE TO BE EVALUATED BY A THIRD PARTY CONTRACTOR OF THE BOWLING GREEN ECONOMIC DEVELOPMENT AUTHORITY AND REMEDIATION PRICING MILL BE BASED ON THEIR RECOMMENDATION. SEE TYPICAL SINKHOLE REPAIR DETAIL ON SHEETS C3.1 & C3.2.

BOWLING

2101

4

5 COSMA DRIVE NG GREEN ,KY 42

106

CARTER LUMBER

2018-04-DP Page Page 150 23

JOB NUMBER: 17-3159 -


DATE: 03/6/2018 SCALE: 1" = 60'

DRAWN: B. McDANIEL CHECKED: A. ARNOLD

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SITE LAYOUT **ENLARGEMENT** 



Page=V|\$200|\$ 23

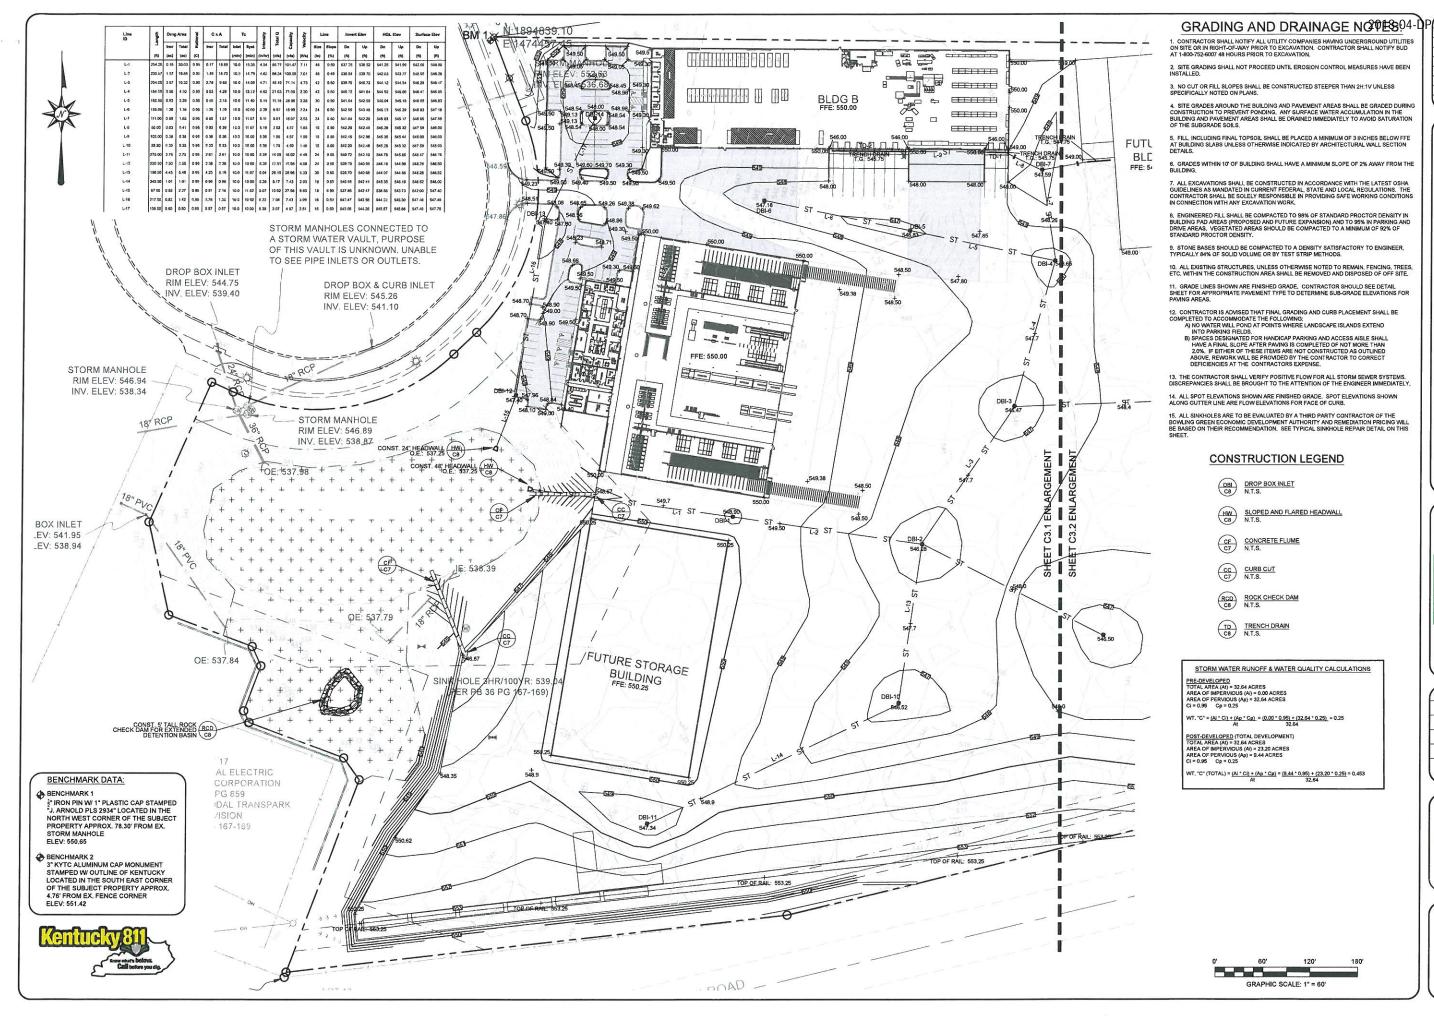CARTER LUMBER 106 COSMA DRIVE BOWLING GREEN ,KY 42101

ARNOLD CONSULTING
ENGINEERING SERVICES, INC.
P.O. BOX 138
BOWLING GREEN, KY 42101

JOB NUMBER: 17-3159


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CHECKED: A. ARNOLD

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C3.1
SITE GRADING & DRAINAGE



### GRADING AND DRAINAGE NOTES 94-1

1. CONTRACTOR SHALL NOTIFY ALL UTILITY COMPANIES HAVING UNDERGROUND UTILITIES ON SITE OR IN RIGHT-OF-WAY PRIOR TO EXCAVATION. CONTRACTOR SHALL NOTIFY BUD AT 1-800-752-6007 48 HOURS PRIOR TO EXCAVATION.

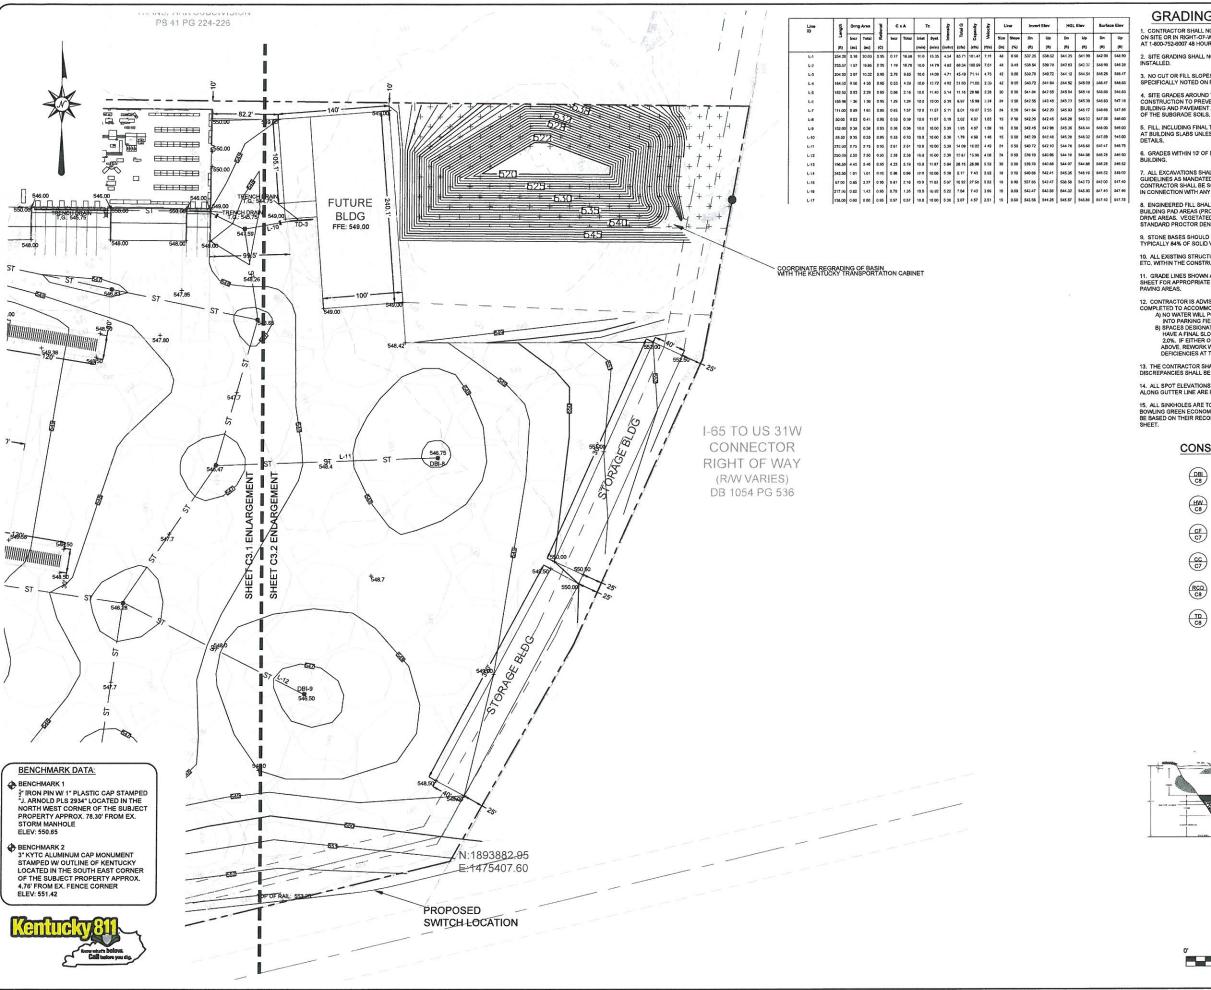2. SITE GRADING SHALL NOT PROCEED UNTIL EROSION CONTROL MEASURES HAVE BEEN INSTALLED.

3, NO CUT OR FILL SLOPES SHALL BE CONSTRUCTED STEEPER THAN 2H:1V UNLESS SPECIFICALLY NOTED ON PLANS.

4. SITE GRADES AROUND THE BUILDING AND PAVEMENT AREAS SHALL BE GRADED DURING CONSTRUCTION TO PREVENT PONDING. ANY SURFACE WATER ACCUMULATION IN THE BUILDING AND PAVEMENT AREAS SHALL BE DRAINED IMMEDIATELY TO AVOID SATURATION OF THE SUBGRADE SOILS.

5. FILL, INCLUDING FINAL TOPSOIL SHALL BE PLACED A MINIMUM OF 3 INCHES BELOW FFE AT BUILDING SLABS UNLESS OTHERWISE INDICATED BY ARCHITECTURAL WALL SECTION DETAILS.

GRADES WITHIN 10° OF BUILDING SHALL HAVE A MINIMUM SLOPE OF 2% AWAY FROM THE BUILDING.

7. ALL EXCAVATIONS SHALL BE CONSTRUCTED IN ACCORDANCE WITH THE LATEST OSHA GUIDELINES AS MANDATED IN CURRENT FEDERAL. STATE AND LOCAL REGULATIONS. THE CONTRACTOR SHALL BE SOLELY RESPONSIBLE IN PROVIDING SAFE WORKING CONDITIONS IN CONNECTION WITH ANY EXCAVATION WORK.

8. ENGINEERED FILL SHALL BE COMPACTED TO 98% OF STANDARD PROCTOR DENSITY IN BUILDING PAD AREAS (PROPOSED AND FUTURE EXPANSION) AND TO 95% IN PARKING AND RIVE AREAS. VEGETATED AREAS SHOULD BE COMPACTED TO A NIMINUM OF 92% OF

ALL EXISTING STRUCTURES, UNLESS OTHERWISE NOTED TO REMAIN, FENCING, TREES, ETC, WITHIN THE CONSTRUCTION AREA SHALL BE REMOVED AND DISPOSED OF OFF SITE.

12. CONTRACTOR IS ADVISED THAT FINAL GRADING AND CURB PLACEMENT SHALL BE COMPLETED TO ACCOMMODATE THE FOLLOWING:

A) NO WATER WILL POND AT POINTS WHERE LANDSCAPE ISLANDS EXTEND INTO PARNING FILEDS.

B) SPACES DESIGNATED FOR HANDICAP PARKING AND ACCESS AISLE SHALL HAVE A FINAL SLOPE AFTER PAVING IS COMPLETED OF NOT MORE THAN 2.0%. IF EITHER OF THESE ITEMS ARE NOT CONSTRUCTED AS OUTLINED ABOVE, REWORK WILL BE PROVIDED BY THE CONTRACTOR TO CORRECT DEFICIENCIES AT THE CONTRACTORS EXPENSE.

13. THE CONTRACTOR SHALL VERIFY POSITIVE FLOW FOR ALL STORM SEWER SYSTEMS. DISCREPANCIES SHALL BE BROUGHT TO THE ATTENTION OF THE ENGINEER IMMEDIATELY

15. ALL SINKHOLES ARE TO BE EVALUATED BY A THIRD PARTY CONTRACTOR OF THE BOWLING GREEN ECONOMIC DEVELOPMENT AUTHORITY AND REMEDIATION PRICING WILL BE BASED ON THEIR RECOMMENDATION. SEE TYPICAL SINKHOLE REPAIR DETAIL ON THIS

### CONSTRUCTION LEGEND

DBI DROP BOX INLET N.T.S.


SLOPED AND FLARED HEADWALL N.T.S.


CF CONCRETE FLUME N.T.S.

CC CURB CUT N.T.S.

RCD ROCK CHECK DAM N.T.S.

TD TRENCH DRAIN N.T.S.

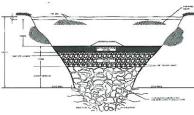

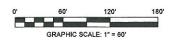

42101 LUMBER S COSMA DRIVE NG GREEN, KY 42 CARTER BOWLING 106

JOB NUMBER: 17-3159 -DATE: 03/06/2018


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SCALE: 1" = 60'

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SITE GRADING & DRAINAGE



TYPICAL SHRUB PLANTING DETAIL

TYPICAL PLANTING DETAIL- EVERGREEN TREES

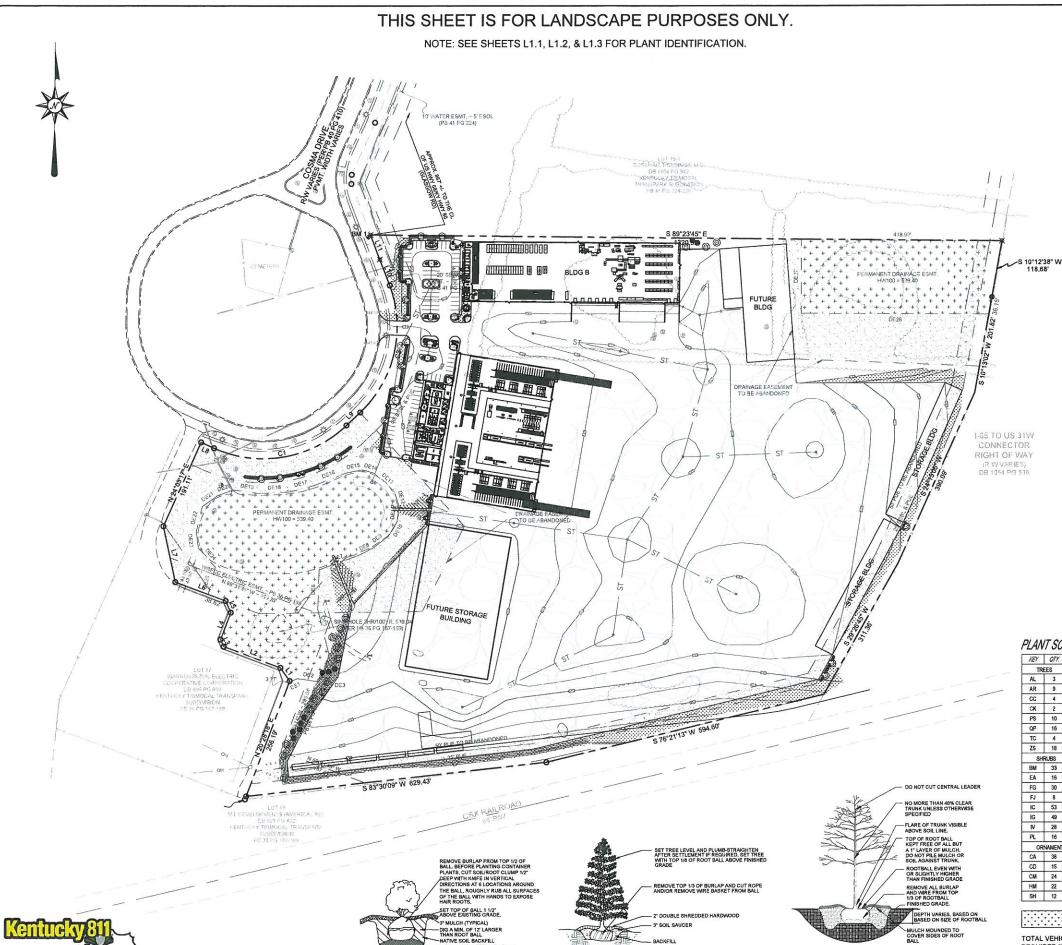LANDSCAPE NOTES: 2018-04-DP Page 150 23

 PLANT MATERIALS SHALL CONFORM IN SIZE AND GRADE TO AMERICAN STANDARDS
FOR NURSERY STOCK, PLANT MATERIALS SHALL BE OF STANDARD QUALITY TRUE TO
NAME AND TYPE, AND FIRST CLASS REPRESENTATIVES OF THEIR SPECIES OR VARIETY PLANTS SHALL BE CAREFULLY LABELED AND SIZES NOTED, RIGHT IS RESERVED TO REJECT PLANTS CONSIDERED AS UNSATISFACTORY. REJECTED PLANTS SHALL BE REMOVED FROM SITE, PLANTS SHOULD NOT BE PRUNED PRIOR TO DELIVERY, HEADING-BACK PLANTS TO MEET SIZES INDICATED IN DRAWINGS SCHEDULE WILL NOT

- PLANTS & TREES
   A. CONTRACTOR SHALL STAKE THE LOCATION OF EACH TREE AND SHRUB IN ACCORDANCE WITH THE LOCATIONS SHOWN ON THE DRAWINGS. STAKING AND LAYOUT WORK SHALL BE DONE SUFFICIENTLY IN ADVANCE OF PLANTING OPERATION TO PERMIT THE LANDSCAPE DESIGNER TO CHECK, REVISE IF DESIRED, AND APPROVE THE LOCATIONS BEFORE DIGISING OPERATIONS BEGIN.
- B. EXCAVATE PLANTING BEDS AND POCKETS TO A DEPTH REQUIRED FOR PLANTINGS.
  C. ANY ROCK OR OTHER UNDERGROUND OBSTRUCTION SHALL BE REMOVED TO DEPTH NECESSARY TO PERMIT PLANTING ACCORDING TO THESE SPECIFICATION.
- D. IN GENERAL, CONTRACTOR SHALL THOROUGHLY WATER ALL PLANTED AREAS AFTER PLANTING AND IN DRY WEATHER USE ENOUGH WATER TO THOROUGHLY SOAK ALL TREE PITS BEFORE PLANTING. CONTRACTOR SHALL MAKE NECESSARY ARRANGEMENTS IN ADVANCE OF START OF THE WORK TO INSURE THAT AN ADEQUATE SUPPLY OF WATER AND WATERING EQUIPMENT ARE AVAILABLE WHEN

### 3 MULCHING

- MULCHING
  A. MULCH TOP OF ROOT BALL AND SAUCER WITHIN 48 HOURS TO A MINIMUM DEPTH
  OF 2" AND TO A DEPTH NOT TO EXCEED 3".

  B. ALL SHADE AND FLOWERING TREES SHALL BE MULCHED WITH THREE (3) INCHES
- THICK (SETTLED) AND COVERING AN AREA TWELVE (12) INCHES GREATER THAN THE DIAMETER OF PIT.

### 4. PLANT MAINTENANCE

- A. MAINTENANCE SHALL BEGIN IMMEDIATELY AFTER EACH PLANT IS PLANTED AND SHALL CONTINUE FOR 90 DAYS AFTER THE LAST PLANT HAS BEEN INSTALLED.

  B. ALL PLANTS SHALL BE KEPT IN A GROWING, HEALTHY CONDITION BY WATERING,
- PRIMING SHEARING SPRAYING TIGHTENING OF GUYS STRAIGHTENING OF PROVING, SHEARING, SHRATING, HIGH LEWING OF GOTS, STRAIGHT LINING OF PLANTS WHICH LEAN OR SAG, LIFTING PLANTS WHICH DEVELOP MORE THAN NORMAL SETTLEMENT, WEEDING, AND BY ANY OTHER NECESSARY OPERATION OF MAINTENANCE, KEEP ALL PLANTING AREAS FREE OF WEEDS AND UNDESIRABLE
- MAINTENANCE, REEF RELE TOUTHOUSE OF THE MAINTENANCE PERIOD, PLANTS IN AN UNHEALTHY OR BADLY IMPAIRED CONDITION, SHALL BE REMOVED AND REPLACED IMMEDIATELY USING SPECIFIED MATERIAL.

- 5. ACCEPTANCE AND GUARANTEE
  A. ANY PLANT REQUIRED UNDER THIS CONTRACT THAT IS DEAD OR WITHOUT ANT PLANT REQUIRED ONDER THIS CONTRACT THAT IS DEAD OF WITHOUT SATISFACTORY GROWN, AS DETERMINED BY THE LANDSCAPE ARCHITECT, SHALL BE REMOVED AND REPLACED IN NEXT SPECIFIED PLANTING SEASON. ANY REPLACEMENTS SHALL BE PLANTS OF THE SAME KIND AND SIZE AS SPECIFIED AND REPLANTED IN SAME LOCATION FROM WHICH DEAD PLANT WAS REMOVED AND SHALL BE REPLACED AT NO ADDITIONAL COST.

  B. ALL PLANT MATERIAL SHALL HAVE A ONE YEAR WARRANTY FOR REPLACEMENT.
- 6 DURING THE BIDDING PROCESS, NO PLANTS MAY BE SUBSTITUTED FOR A DIFFERENT PLANT, THE PLAN MUST BE BID AS DRAWN.
- 7. THE LANDSCAPE CONTRACTOR SHALL BE REQUIRED TO COME BACK AFTER ONE YEAR OF ACCEPTANCE OF THE PLANTING TO REMOVE ANY STAKES OR GUY WIRES THAT MAY HAVE BEEN USED
- 8 ANY DISCREPANCY BETWEEN THE PLANTING PLAN AND THE PLANT SCHEDULE SHALL BE BROUGHT TO THE ATTENTION OF THE LANDSCAPE ARCHITECT AND THE QUANTITIES SHOWN ON THE PLAN SHALL TAKE PRECEDENCE OVER THE PLANT SCHEDULE.
- 9. THE OWNER RESERVES THE RIGHT TO ALTER THE PLANTING PLAN AS SHOWN IN THE

MULCH: ALL SHRUBS THAT ARE SHOW IN GROUPINGS. SHALL BE MULCHED IN A PLANT MOLOH, ALL SHRUDGS THAT ARE SHOWN IN GROUPHINGS, STALL BE MOLCHED IN A PENNT BED WITH 5 HREDDED HARDWOOD MULCH TO A MINIMUM OF 2" AND NOT GREATER THAN 3" IN DEPTH. IN AREAS OF STEEP SLOPES A FINE GRADE (NEARLY INVISIBLE) PLASTIC NETTING MAY BE USED TO STABILIZE THE MULCH BED.

ANNUALS AND PERENNIALS: ANY DESIRED ANNUALS AND PERENNIALS MAY BE DETERMINED BETWEEN THE PROPERTY OWNER AND THE LANDSCAPE CONTRACTOR FOR DESIRED COLOR PALETTE.

### PLANT SCHEDULE - OVERALL

KEY	QTY.	BOTANICAL NAME	COMMONNAME	SIZE	ROOT	REMARKS	
TRE	ES						
AL	3	AMELANCHIER LAEVIS 'PRINCE CHARLES'	ALLEGHENY SERVICEBERRY	5-6 HT.	5-6 HT. BAB W		
AR	9	ACER RUBRUM 'RED SUNSET'	RED MAPLE	13/4" CAL. B&B		WELL BRANCHED	
cc	4	CERCIS CANADENSIS 'FOREST PANSY'	EASTERN REDBUD	5-6 HT.	5-6 HT. B&B WEI		
CK	2	CORNUS KOUSA	KOUSA DOGWOOD	5-6 HT.	B&B	WELL BRANCHE	
PS	10	PINUS STROBUS	EASTERN WHITE PINE	5-6 HT.	B&B	WELL BRANCHE	
QP	16	QUERCUS PHELLOS	WILLOW OAK	13/4" CAL.	B&B	WELL BRANCHE	
TC	4	TILIA CORDATA 'GREENSPIRE'	LITTLELEAF LINDEN	13/4" CAL.	B&B	WELL BRANCHE	
ZS	18	ZELKOVA SERRATA "VILLAGE GREEN"	JAPANESE ZELKOVA	13/4" CAL.	B&B	WELL BRANCHE	
SH	RUBS	A STEE SEC SOME STEEL STEEL					
ВМ	33	BUXUS MICROPHYLLA WINTERGREEN	LITTLELEAF BOXWOOD	24" HT. B&B		WELL BRANCHE	
EA	16	EUONYMUS ALATUS 'COMPACTUS'	WINGED EUONYMUS	24" HT.	B&B	WELL BRANCHE	
FG	30	FOTHERGILLA GARDENII	DWARF FOTHERGILLA	24" HT.	B&B	WELL BRANCHE	
FJ	8	FOTHERGILLA GARDENII 'JANE PLATT'	DWARF FOTHERGILLA	24 HT. B&B		WELL BRANCHE	
Ю	53	ILEX CRENATA 'HELLERI'	BOX-LEAVED HOLLY	24" HT. B&B		WELL BRANCHE	
IG	49	ILEX GLABRA	INKBERRY	24" HT. B&B		WELL BRANCHE	
IV	28	ILEX VERTICILLATA 'RED SPRITE'	COMMON WINTERBERRY	24" HT.	B&B	WELL BRANCHE	
PL	16	PRUNUS LAUROCERASUS 'OTTO LUYKEN'	CHERRYLAUREL	24" HT.	B&B	WELL BRANCHE	
OR	VAMENT	AL GRASSES					
CA	38	CALAMAGROSTIS ACUTIFLORA 'KARL FOERSTER'	FEATHER REED GRASS	3 GAL, CLUMP			
CD	15	CAREX DOLICHOSTACHYA 'KAGA NISHIKI'	GOLD FOUNTAINS SEDGE	3 GAL, CLUMP			
CM	24	CAREX MORROWII ICE DANCE'	JAPANESE SEDGE	3 GAL, CLUMP			
НМ	22	HAKONECHLOA MACRA 'AUREOLA'	GOLDEN JAPANESE FOREST GRASS	3 GAL. CLUMP			
CH	12	SPOROBOLLIS HETEROLERIS	PRAIRIE DROPSEED	3 GAL CLUMP			

AREA OF SOD: 6,252 SQUARE YARDS. SOD TO BE A LOCALLY GROWN TYPE TYPE FESCUE. SOD TO BE PLACED WITHIN 24 HOURS OF HARVEST

TOTAL VEHICULAR USE AREA: REQUIRED INTERIOR LANDSCAPING: 7,008 SF (20%) PROVIDED INTERIOR LANDSCAPING: 7,339 SF (20.9%)

TYPICAL PLANTING DETAIL- TREES


GRAPHIC SCALE: 1" = 100"

**OVERALL** LANDSCAPE PLAN

LUMBER DRIVE GREEN COSMA ARTER BOWLING 106

JOB NUMBER: 17-3159-DATE: 03/06/2018 SCALE: 1" = 100' DRAWN: K. CARDWELL CHECKED: B. SHIRLEY

FILE PATH:

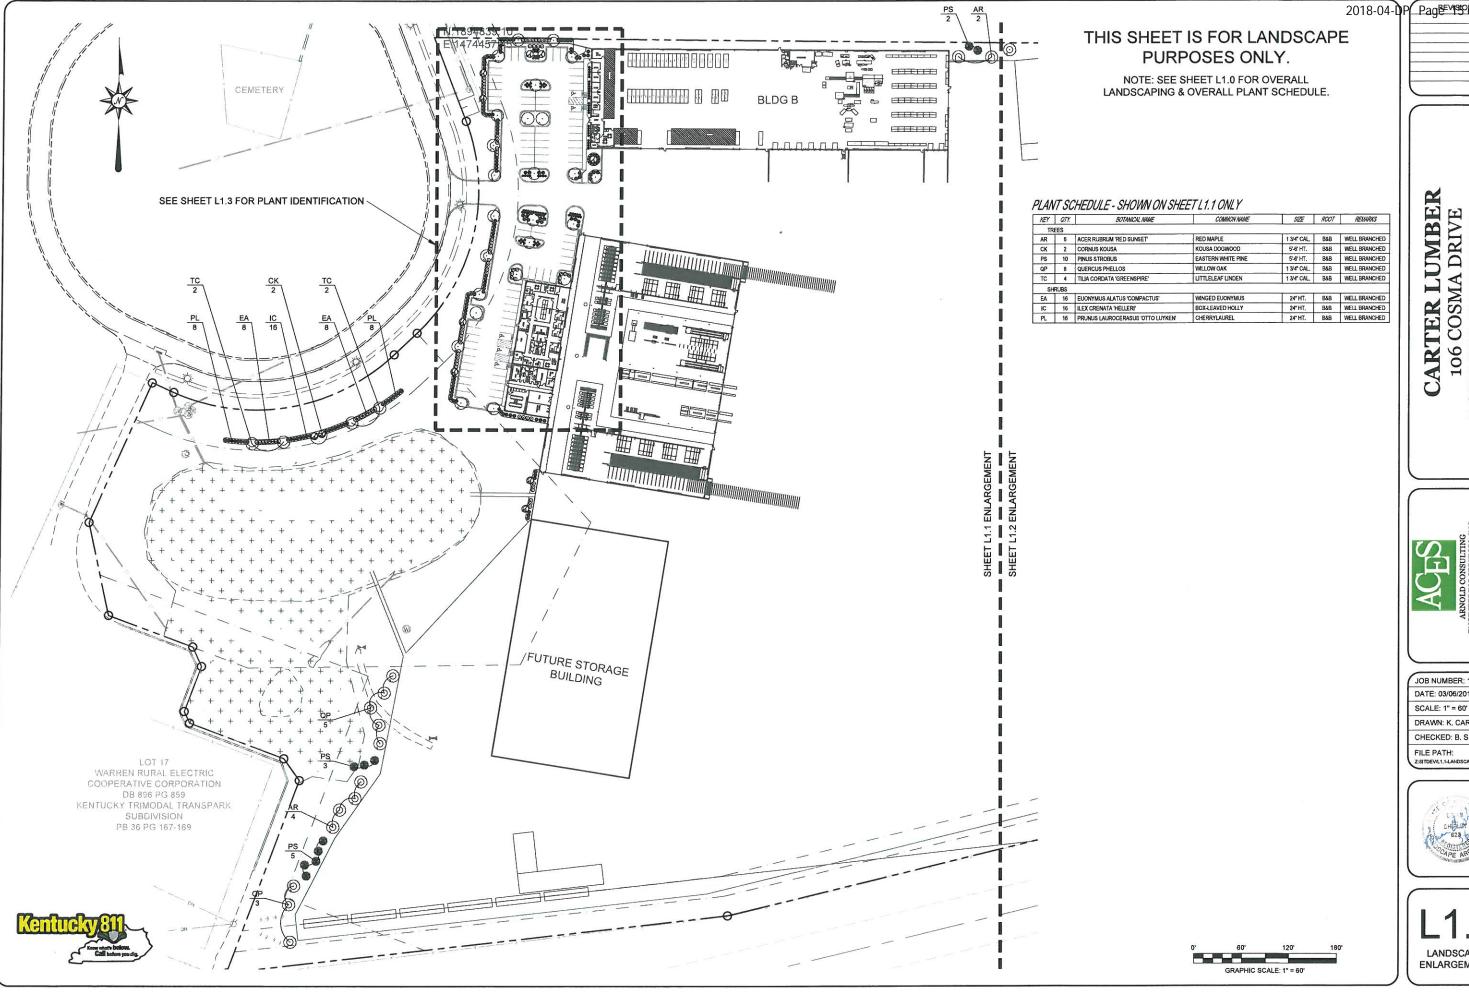

2018-04-DP Page 1950 1 23

106 COSMA DRIVE BOWLING GREEN ,KY 42101 LUMBER CARTER




JOB NUMBER: 17-3159 -DATE: 03/06/2018

DRAWN: K. CARDWELL CHECKED: B. SHIRLEY





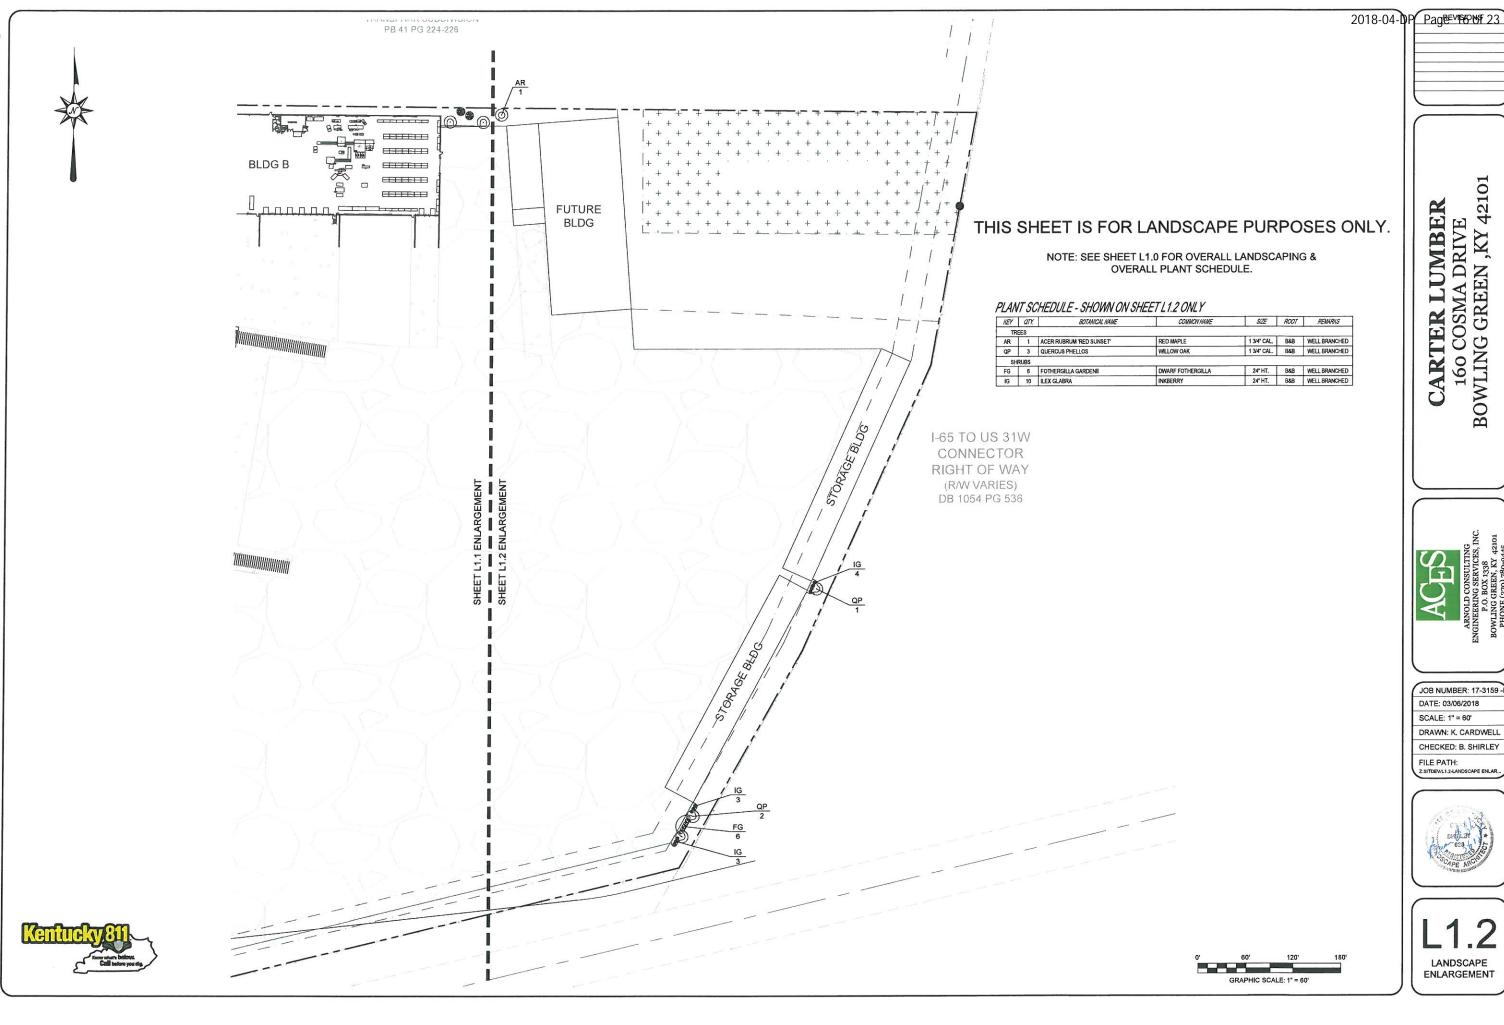

CARTER LUMBER 160 COSMA DRIVE BOWLING GREEN ,KY 42101

JOB NUMBER: 17-3159 -L DATE: 03/06/2018 SCALE: 1" = 60' DRAWN: K. CARDWELL

CHECKED: B. SHIRLEY FILE PATH:



LANDSCAPE **ENLARGEMENT** 

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CARTER LUMBER 106 COSMA DRIVE BOWLING GREEN ,KY 42101

ARNOLD CONSULTING
ARNOLD CONSULTING
NGINEERING SERVICES, INC.
P.O. BOX 1338
SOWLING CREEN, Y 42201
PHONE (272) 'ABLOADE

JOB NUMBER: 17-3159-L DATE: 03/06/2018 SCALE: 1" = 20'

DRAWN: K. CARDWELL CHECKED: B. SHIRLEY

FILE PATH: z:sitdev/l1.3-lan




L1.3

LANDSCAPE
ENLARGEMENT

THIS SHEET IS FOR LANDSCAPE PURPOSES ONLY.

NOTE: SEE SHEET L1.0 FOR OVERALL LANDSCAPING & OVERALL PLANT SCHEDULE.

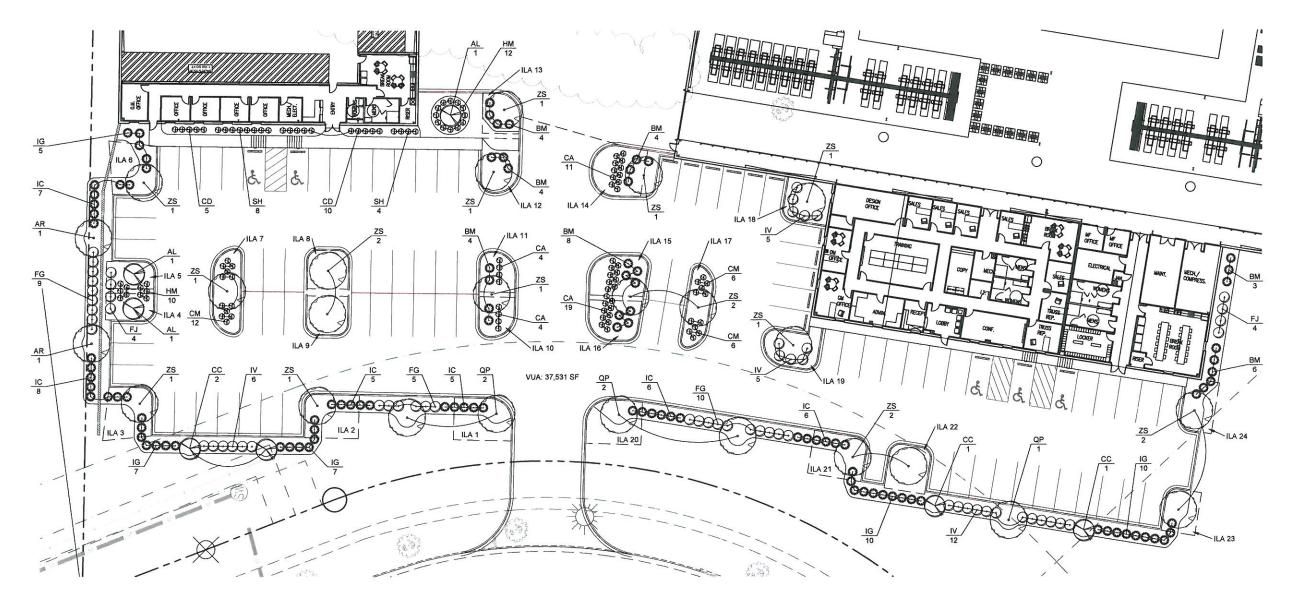


### PLANT SCHEDULE - SHOWN ON SHEET L1.3 ONLY

KEY	QTY.	BOTANICAL NAME	COMMON NAME	SIZE	ROOT	REMARKS	
TRI	EES						
AL	3	AMELANCHIER LAEVIS 'PRINCE CHARLES'	ALLEGHENY SERVICEBERRY	5-6 HT.	B&B	WELL BRANCHED	
AR	2	ACER RUBRUM 'RED SUNSET'	RED MAPLE	1 3/4" CAL.	13/4" CAL. B&B WELL BRA		
CC	4	CERCIS CANADENSIS 'FOREST PANSY'	EASTERN REDBUD	5-6 HT.	B&B	WELL BRANCHED	
QP	5	QUERCUS PHELLOS	WILLOW OAK	13/4" CAL.	B&B	WELL BRANCHED	
ZS	18	ZELKOVA SERRATA VILLAGE GREEN	JAPANESE ZELKOVA	1 3/4" CAL.	B&B	WELL BRANCHED	
SHI	RUBS					10000000	
BM	33	BUXUS MICROPHYLLA WINTERGREEN	LITTLELEAF BOXWOOD	24" HT.	B&B	WELL BRANCHED	
FG	24	FOTHERGILLA GARDENII	DWARF FOTHERGILLA	24" HT.	B&B	WELL BRANCHED	
FJ	8	FOTHERGILLA GARDENII 'JANE PLATT'	DWARF FOTHERGILLA	24" HT.	B&B	WELL BRANCHED	
IC	37	ILEX CRENATA 'HELLERI'	BOX-LEAVED HOLLY	24" HT.	B&B	WELL BRANCHED	
IG	39	ILEX GLABRA	INKBERRY	24" HT,	B&B	WELL BRANCHED	
IV	28	ILEX VERTICILLATA 'RED SPRITE'	COMMON WINTERBERRY	24" HT.	B&B	WELL BRANCHED	
OR	NAMENT	AL GRASSES					
CA	38	CALAMAGROSTIS ACUTIFLORA 'KARL FOERSTER'	FEATHER REED GRASS	3 GAL, CLUMP			
CD	15	CAREX DOLICHOSTACHYA 'KAGA NISHIKI'	GOLD FOUNTAINS SEDGE	3 GAL, CLUMP			
CM	24	CAREX MORROWII TCE DANCE	JAPANESE SEDGE	3 GAL. CLUMP			
НМ	22	HAKONECHLOA MACRA 'AUREOLA'	GOLDEN JAPANESE FOREST GRASS	3 GAL. CLUMP			
SH	12	SPOROBOLUS HETEROLEPIS	PRAIRIE DROPSEED	3 GAL, CLUMP			

	VUA & IL	A CHART	
	TOTAL VUA:	37,531 SF	
-	REQUIRED ILA:	7,507 SF (20%)	
	PROVIDED ILA:	7,544 SF (20.1%)	
ILA NUMBER	SQUARE FOOTAGE	ILA NUMBER	SQUARE FOOTAGE
1	400 SF	13	238 SF
2	400 SF	14	400 SF
3	400 SF	15	364 SF
4	219 SF	16	318 SF
5	219 SF	17	276 SF
6	398 SF	18	323 SF
7	344 SF	19	314 SF
8	264 SF	20	399 SF
9	264 SF	21	400 SF
10	215 SF	22	315 SF
11	219 SF	23	252 SF
12	318 SF	24	285 SF
		TOTAL	7.544 SF



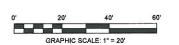

60 DE150 BE140

to to

**GENERAL NOTES** 

NOTES:

1. READINGS SHOWN ARE IN UNITS OF MAINTAIN FOOTCANDLES.

1. READINGS SHOWN ARE IN UNITS OF MAINTAIN FOOTCANDLES.
2. LITHONIA LIGHTING FIXTURES USED IN MODEL (SEE SCHEDULE THIS SHEET & MECHANICAL PLANS FOR FURTHER DETAILS).
3. FIXTURES SHALL MATCH AS NOTED OR EQUIVALENT PER OWNER.
4. A MOUNTING HEIGHT: 25'

**B MOUNTING HEIGHT: 25'** 

5. ALL FIXTURES AND POLES TO BE DARK BRONZE.
6. READINGS TAKEN AT GRADE
7. SEE MECHANICAL/ELECTRICAL PLANS FOR EXACT LOCATION OF BUILDING MOUNTED FIXTURES AND WALL PACKS

8. FIXTURE SPACING AS SHOWN 9. L.L.F. CALCULATED AT 0.72

10. THE CONTRACTOR SHALL VERIFY TOTAL LINEAR FEET OF CONDUIT

AND WIRE GAUGE SIZE IS ADEQUATE.

11.IT SHALL BE THE CONTRACTORS RESPONSIBILITY TO COORDINATE WITH MECHANICAL ENGINEER TO ENSURE ELECTRICAL PANEL


LOADING REQUIREMENTS ARE MET AND NOT EXCEEDED.

12. CONTRACTOR SHALL COORDINATE WITH MECHANICAL PLANS FOR CONNECTION TO ELECTRICAL SERVICE PANEL.

13. CONTRACTOR SHALL VERIFY THAT ALL ELECTRICAL CONNECTIONS

MEET LOCAL BUILDING CODES AND LOADING REQUIREMENTS.

14. ANY DISCREPANCIES BETWEEN ARCHITECTURAL, MECHANICAL, AND SITE LIGHTING PLANS SHALL BE BROUGHT TO THE ENGINEERS ATTENTION FOR REVIEW.

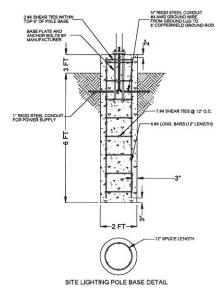

Symbol Avg Max Min Max/Min Avg/Min

GRAPHIC SCALE: 1" = 50"

# 106 COSMA DRIVE BOWLING GREEN ,KY 42101 LUMBER CARTER

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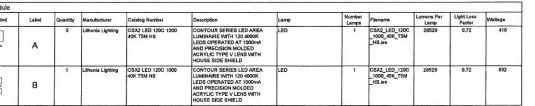
JOB NUMBER: 17-3159-L DATE: 03/06/2018 SCALE: 1" = 50'

DRAWN: C. WICKER CHECKED: A. ARNOLD

FILE PATH









Symbol	Label	Quantity	Manufacturer	Catalog Number	Description	Lamp	Number Lamps	Filename	Lumens Per Lamp	Light Loss Factor	Wattage
	А	5	Lithonia Lighting	CSX2 LED 120C 1000 40K T5M HS	CONTOUR SERIES LED AREA LUMINAIRE WITH 120 4000K LEDS OPERATED AT 1000mA AND PRECISION MOLDED ACRYLIC TYPE V LENS WITH HOUSE SIDE SHIELD	LED	1	CSX2_LED_120C _1000_40K_T5M _HS.les	28529	0.72	416
o ā	В	1	Lithonia Lighting	CSX2 LED 120C 1000 40K T5M HS	CONTOUR SERIES LED AREA LUMINARE WITH 120 4000K LEDS OPERATED AT 1000mA AND PRECISION MOLDED ACRYLIC TYPE V LENS WITH	LED	1	CSX2_LED_120C _1000_40K_T5M _HS.ies	28529	0.72	832

to BE ABANDONED

